

SAND PIPER COTTAGES SECTION 2 TOWNSHIP 4 SOUTH RANGE 3 EAST TULF SHORES, BALDWIN COUNTY, ALABAMA	0 20 40 60	
DATE OF PLAT: JANUARY 17, 2022 State of Alabanta) Interior (1997) The administration of the Vision, Licensed Land Surveys: State of Alabanta, Edward LLC, Charles, Insultry partly that this past or made weak make to consider a source made by seed surveys: and note that past or made are noted as the release of seed covers, the this past or made weak made to consider a source made by seed surveys: and note that past or made are noted as the release of seed covers, the this past or made are noted made to consider a form of the specific made as a form of the past or made are noted as a form of the specific made as a		
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PLANNING COMMISSION CHAIRMAN	1 1773/F C 1274	
PLANNING DIRECTOR		
COVENCETE	2,572,50 FT. ±	
APPROVED BY FRIE MARSHAL CERTIFICATE OF APPROVING BY 6 -11 CONSCIONSOFFS The investigated, as activated by 6 states County for 11 move from years on the mod marsha as carpoint on the map within past and handly opposes to we start also the the modern's class of a factor of the modern County, Adamson, this	Summe use	
Authorised Representative No authority to violate cancel or set tooks any of the provisions of the applicable regulations or less of the City of Gulf Shome in intended, implied, or	1 1.80 SQ FT. 2	
WETLAND NOTICE (by emproyed of the Justice of Conference and the Conference probes for representation or asset only, other accelerated or register, that any conference of the Justice of Conference of the Confer	(N) 43 (N)	
regulations governery wetterus as may be 4 effect from time to time Purpose of Subdivision This cuspose of this audiovision is to create 5 single materials role purities with committee reves Subdivision committee and residencies have been recommend in the Office of the Judge of Probate of Belown County Alatomia in	1627 SQ FT	
	WHEN FEET ON NEW STREETS AS NE	SURED #
NOTES: 1. BERRINGS ARE BASED ON GEODECTIC NORTH AS OBTAINED BY GPS OBSERVATION 2. LECAL DESCRIPTION PROVIDED BY CLIENT. 3. THIS PROPERTY WAS SCALED ONTO THE FEDERAL EMERGENCY MANAGEMENT AGENCY'S FLOOD INSURANCE MAP NUMBER OLOGICIOSEM EFFECTIVE 4/19/2019 AND FOUND TO BE IN ZONE AE (EL 1 FEET).	General Aller of State of Stat	
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ACCESS EASEMENT NOTE: THERE IS A "ACCESS EASEMENT FOR ALL LOTS FRONTING OR ADJACENT TO PRIVATE ROADS TO		
FRONTING ON ADJACENT TO PHYVALE YOUNGS TO ALLOW FOR A TOTAL WIDTH OF A WINIMUM OF 22" OF ACCESS	SW # HICS	

GENERAL NOTES:

- IT IS THE RESPONSIBILITY OF THE CONTRACTOR TO OBTAIN ALL NECESSARY PERMITS REQUIRED TO CONSTRUCT THIS PROJECT AND PAY ALL PERMIT FEES. ALL PERMITS MUST BE IN-HAND PRIOR TO CONSTRUCTION.
 THE CONTRACTOR IS RESPONSIBLE FOR ALL METHODS, PROCEDURES, AND SEQUENCES OF CONSTRUCTION.
 CONSTRUCTION SITE SAFTY, INCLUDING ALL ADEQUATE TEMPORARY BRANCH AND SHORING, IS THE SOLE RESPONSIBILITY OF THE CONTRACTOR.
 THE LOCATION OF EXISTING UTILITIES SHOWN ON DRAWINGS ARE APPROXIMATE, THE CONTRACTOR SHALL MAKE EVERY REASONABLE EFFORT TO FIELD LOCATE ANY AND ALL UTILITIES PRIOR TO ORDERING MATERIALS AND/OR BEGINNING CONSTRUCTION, ANY AND ALL DISCREPANCIES SHALL BE REPORTED TO LIEB ENGINEERING IMMEDIATELY. THE CONTRACTOR SHALL EXERCISE DUE CARE TO PROTECT THEM FROM DAMAGE DURING
- XCAVATION AND CONSTRUCTION THE CONTRACTOR SHALL TAKE ALL NECESSARY MEASURES TO PROTECT ADJACENT PROPERTIES AND IS RESPONSIBLE FOR ANY DAMAGE TO EXISTING IMPROVEMENTS ON OR OFF SITE DUE TO THE CONSTRUCTION OF THIS PROJECT. ANY DAMAGE WILL BE REPAIRED AT THE
- CONTRACTOR'S EXPENSE.

 ALL EXCAMATIONS SHALL ADHERE TO THE PROVISIONS OF THE MOST CURRENT OSHA STANDARDS AND SPECIFICATIONS,

 THIS PROPERTY IS IN ZONE "Ac" AS PER THE MAP BY THE FEDERAL EMERGENCY MANAGEMENT AGENCY, FEDERAL INSURANCE ADMINISTRATION
 COMMUNITY PANEL NUMBER 1077 FOR BALDWIN COUNTY AND MAP NUMBER 01003C1077M AS PER REVISED MAP DATED APRIL 19, 2019.

 SURVEY DATA WAS COMPILED FROM A 10POGRAPHIC SURVEY PROVIDED BY WEIGAND, WILSON.

SITE DEMOLITION NOTES:

- ALL EXISTING IMPROVEMENTS SHALL REMAIN WITHIN THE LIMITS OF CONSTRUCTION UNLESS SPECIFICALLY NOTED, TO BE REMOVED", CONTRACTOR SHALL COORDINATE WITH OWNER REGARDING ITEMS TO BE SALVAGED, REMOVED AND REUSED, ETC., CONTRACTOR TO USE CAUTION NOT TO DAMAGE THESE ITEMS DURING REMOVAL AND/OR REUSE, ANY DAMAGED ITEMS SHALL BE REPAIRED/REPLACED AT CONTRACTOR'S
- ANY AND ALL UTILITIES IN CONFLICT WITH PROPOSED IMPROVEMENTS SHALL BE REMOVED OR RELOCATED. COORDINATE WITH UTILITY PROVIDER PRIOR TO REMOVAL/RELOCATION.
 4. SAWCUT EXISTING HARDSCAPES AT LIMITS OF REMOVAL. ASPHALT PAYING SHALL BE MILLED A MINIMUM OF 8" TO ENSURE A SMOOTH
- TRANSITION TO PROPOSED ASPHALT PAYING.
 CONTRACTOR TO DISPOSE OF ALL DEMOLITION AND CONSTRUCTION DEBRIS AT LEAST WEEKLY IN AN APPROVED MANOR
- THE CONTRACTOR IS RESPONSIBLE FOR THE REMOVAL RELOCATION OR PROTECTION OF ALL ABOVE AND BELOW GROUND EXISTING IMPROVEMENTS THAT ARE IN CONFLICT WITH THE PROPOSED IMPROVEMENTS UNLESS NOTED.

LAYOUT NOTES:

- 12 TOPOGRAPHY AND SITE BOUNDARIES SHALL BE FIELD VERIFIED BY CONTRACTOR PRIOR TO ORDERING MATERIALS AND/OR BEGINNING
- CONSTRUCTION, IMMEDIATELY NOTIFY LIEB ENGINEERING OF ANY DISCREPANCIES,
 2. ALL DIMENSIONS AND COORDINATES SHOWN ARE TO THE OUTSIDE FACE OF BUILDING TO THE BACK OF CURB, OR TO THE EDGE OF
- SURFACING UNLESS OTHERWISE NOTED: 3. IT IS THE CONTRACTOR'S RESPONSIBILITY TO PROTECT ALL BENCHMARKS AND PROPERTY CORNERS. ANY REPLACEMENT WILL BE AT THE CONTRACTOR'S
- EXPENS.

 VERIFY ALL DIMENSIONS AND CONDITIONS RELATED TO EXISTING CONDITIONS IN THE FIELD PRIOR TO CONSTRUCTION, ANY DISCREPANCIES
 SHALL BE BROUGHT TO THE IMMEDIATE ATTENTION OF LIEB ENGINEERING, WRITTEN DIMENSIONS TAKE PROCEEDENCE OVER SCALE IS FOR
 CUIDELINE PURPOSES ONLY. IF DIMENSIONS ARE UNCLEAR, DO NOT SCALE, REQUEST CLARIFICATION FROM THE ENGINEER.

 CONTRACTOR SHALL FOLLOW STATE REQUIREMENTS FOR SURVEY PRACTICES FOR CONSTRUCTION LAYOUT WORK.

UTILITY NOTES:

ALABAMA ONE-CALL THE CONTRACTOR IS REQUIRED TO CALL "ALABAMA ONE-CALL" 1-800-292-8525 AT LEAST 48 HOURS PRIOR TO ANY EXCAVATION AND SHALL EXERCISE EXTREME CARE TO AVOID DAMAGING EXISTING UTILITIES.

- THE SITE CONTRACTOR IS RESPONSIBLE FOR COMPLETING ALL UTILITY SERVICES (WATER, ELECTRICAL, TELEPHONE, CABLE TV) FROM THE POINT THE RESPECTIVE UTILITY COMPANY COMPLETES THEIR WORK TO THE POINT OF CONNECTION AT THE BUILDING.

 2. REFER TO ARCHITECTURAL, MECHANICAL, PLUMBING, ELECTRICAL, ETC. PLANS FOR ALL PROPOSED UTILITY POINTS OF CONNECTION AT THE BUILDING, NOTH'S ARCHITECT, LIEB ENGINEERING OF ANY DISCREPANCIES.

 3. BACKFLOW PREVENTION AND METERING SHALL BE PROVIDED ON THE FIRE, DOMESTIC, AND IRRIGATION SERVICES IN ACCORDANCE WITH THE
- LOCAL UTILITY COMPANY AND FIRE DEPARTMENT'S REQUIREMENTS...
- WATER MAINS AND SERVICES SHALL BE INSTALLED IN ACCORDANCE WITH THE LOCAL UTILITY COMPANY'S REQUIREMENTS. ALL MAINS AND
- WAIEX MAINS AND SERVICES STAILS BE INSTALLED IN A ACCORDANCE HITH THE DOCK OFFICE TO STAIL BE INSTALLED WITH A MINIMUM OF 36" COPE UNLESS OTHERWISE INDICATED ON PLANS.

 ALL SANITARY SEWER MAINS AND LATERALS SHALL BE PVC SOR 26 UNLESS OTHERWISE REQUIRED BY THE LOCAL UTILITY COMPANY,
 ALL UNDERGROUND ELECTRICAL, TELEPHONE, AND CABLE DY SHALL BE INSTALLED IN PVC COMDUIT OR CONCRETE ENCASED DUCT BANK WITH
 PULL WIRE MEETING THE LOCAL UTILITY COMPANY'S REQUIREMENTS. INFORMATION SHOWN ON CIVIL DRAWINGS FOR REFERENCE ONLY, REFER
- TO ELECTRICAL PLANS FOR SPECIFIC INFORMATION.
 7. UTILITY TRENCHES SHALL BE BACKFILLED WITH COMPACTED FILL PLACED IN 6 INCH LOOSE LIFTS, FILL SHALL BE COMPACTED TO 98%
- STANDARD PROCTOR AND OPTIMUM MOISTURE CONTENT WITHIN ±3%.

 8. WHEN INSTALLING UTILITIES IN EXISTING PAVED AREAS OR IN AREAS WHERE SOILS ARE CONSIDERED UNSUITABLE FOR BEDDING OR
- BACKFILLING, UTILITY TRENCHES SHALL BE BACKFILLED FULL DEPTH WITH SAND.

 9. WHERE UTILITIES ARE TO BE INSTALLED IN AREAS OF EXISTING PAVING, HARDSCAPE, SIDEWALKS, ETC. CONTRACTOR SHALL SAWCUT AND REMOVE EXISTING PAYING, HARDSCAPE, SIDEWALK ETC. AND REPLACE IN LIKE KIND AND RESTRIPE AS NECESSARY. BACKFILL TRENCH FULL

CONCRETE NOTES:

- ALL NORMAL WEIGHT CONCRETE SHALL OBTAIN A MINIMUM 28 DAY COMPRESSIVE STRENGTH OF 3000 PSI UNLESS NOTED OTHERWISE.
- ALL NORMAL WEIGHT CONCRETE SHALL OBTAIN A MINIMUM 2B DAY COMPRESSIVE STRENGTH OF 3000 PSI UNIXESS NUTBED HITECONCRETE.

 C. ACLIUM CHROMEDE AND/OR ADMIXTURES CONTAINING CALCIUM CHLORIDE SHALL NOT BE USED IN THE CONCRETE.

 I. TEST CYLINDERS SHALL BE MADE AND TESTED AS OUTLINED IN THE ACI 301 SPECIFICATION, AND PER PROJECT SPECIFICATIONS.

 REDINFORCING BARS SHALL BE DEFORMED BARS OF NEW BILLET SITED. CONTROVING TO ASTIM A—615, GRADE 60 AND PLACED IN ACCORDANCE WITH ACI—315, LATEST EDITION UNLESS SPECIFICALLY NOTED OTHERWISE ON THE DRAWNINGS.

 FARRICATION OF REINFORCING STEEL SHALL BE IN ACCORDANCE WITH THE "MANUAL OF STANDARD PRACTICE FOR DETAILING REINFORCED
- CONCRETE STRUCTURES" ACI 315,
 UNLESS OTHERWISE NOTED, CONCRETE COVER FOR REINFORCING BARS SHALL CONFORM TO THE MINIMUM REQUIREMENTS OF ACI 318.
- 6. ONCESS CHICAMS NULLEY, CONTROLLE COVER YER REPORTANCE OF ALL SPASS SHALL CONTROM TO HE MINIMOM REQUIREMENTS OF AST 75.

 7. PROVIDE 3/4" BY 45 DEGREE CHAMERE ON ALL EXPOSED CONCRETE EDGES UNLESS NOTED OTHERWISE ON THE DRAWINGS.

 8. TYPE II PORTIAND CEMENT SHALL BE USED IN THE MANUFACTURE OF ALL CONCRETE UNLESS CHERWISE NOTED, PORTIAND CEMENT SHALL CONFORM TO C150, ONLY ONE BRAND OF CEMENT SHALL BE USED FOR ALL CONCRETE UNLESS OTHERWISE NOTED, PORTIAND CEMENT SHALL SED IN THE MANUFACTURE OF CONCRETE SHALL CONFORM TO ASTM C33 UNLESS OTHERWISE NOTED, OCCURRACTOR MAY SUBSTITUTE CONSTRUCTION JOINTS IN LIEU OF CONTROL JOINTS AS NEEDED.

 10. CONTRACTOR MAY SUBSTITUTE CONSTRUCTION JOINTS IN LIEU OF CONTROL JOINTS AS NEEDED.

 11. ECPANSION JOINT MATERIAL SHALL BE BITIMINOUS TYPE PER ASTM 10944.

 12. SEALANT SHALL BE BASE SONOLASTIC SL2, OR OTHER ELASTOMERIC JOINT SEALANT AS APPROVED, ALL SEALANT MATERIAL SHALL BE

- INSTALLED IN STRICT ACCORDANCE WITH MANUFACTURER'S RECOMMENDED INSTALLATION INSTRUCTIONS

GRADING NOTES:

- THE LIMITS OF CLEARING SHALL BE AT THE EDGE OF PROPOSED GRADING OR THE PROPERTY LINE, WHICHEVER IS LESS,
- THE OWNER SHALL BE RESPONSIBLE FOR PROVIDING COMPACTION TESTING.
 ALL TOP SOIL WITHIN LIMITS OF CONSTRUCTION SHALL BE STRIPPED AND STOCKPILED ON SITE IN AN APPROVED MANNER TOPSOIL SHALL BE SPREAD 6" DEEP ON ALL NON HARDSCAPE AREAS TO BRING TO FINISHED GRADE, ANY EXCESS TOPSOIL SHALL BE DISPOSED OF OFF SITE IN
- AN APPROVED MANNER.

 A. IN CUT AREAS, SUBGRADE SHALL BE SCARIFIED A MINIMUM OF 1' AND RECOMPACTED BEFORE PLACING FILL OR ANY OTHER IMPROVEMENTS.

 RECOMPACTION SHALL BEET THE SPECIFIED DENSITY AND MOISTURE CONTENT IN GRADING NOTE \$6.

 CONTRACTOR SHALL BE RESPONSIBLE FOR RESTORING THE SUBGRADE AFTER IT HAS BEEN INITIALLY PREPPED DUE TO INCLEMENT WEATHER AND
- CONSTRUCTURAL FILL FROM AN OFF-SITE BORROW SOURCE SHOULD MEET COLOR REQUIREMENTS OF THE CITY OF GULF SHORES AND MEET THE FOLLOWING MINIMUM REQUIREMENTS:
- EXHIBIT SP CLASSIFICATION ACCORDING TO THE UNIFIED SOIL CLASSIFICATION SYSTEM
- HAVE A MAXIMUM OF 5% SOIL FINES PASSING THE NO. 200 SIEVE
- HAVE A LIQUID LIMIT (LL) LESS THAN 20%
- HAVE A PLASTICITY INDEX (PL) OF 0% (NON-PLASTIC)
- HAVE A MINIMUM STANDARD PROCTOR (ASTM D-698) MAXIMUM DRY DENSITY OF 99 PCT

THE INITIAL LIFT OF SAND FILL (IF ANY) SHOULD BE PLACED IN A 12 INCH THICK LIFT AND COMPACTED TO 95% ASTM D-698 STANDAR COMPACTION. THE REMAINING LIFTS OF FILL REQUIRED TO ACHIEVE FINAL SUBGRADE ELEVATIONS (IF ANY) SHOULD BE PLACED IN 8 TO 12 INCH CORSE LIFTS AND COMPACTED TO 100% ASTM D-698 STANDARD PROCTOR DENSITY AT MOISTURE CONTENTS WITHIN +/- 5% OF THE MATERIAL'S OPTIMAL MOISTURE CONTENT IMMEDIATELY PRIOR TO PLACEMENT OF THE BASE COURSE,
7. PIPE BEDDING SHALL BE "SELECT SAND," THE MATERIAL SHALL CONTAIN LESS THAN 10% PASSING THE \$200 SIEVE AND 90% PASSING THE

- #40 SIEVE, BY WEIGHT, MATERIAL SHALL BE PLACED IN 8" LOOSE LIFTS AND EACH LIFT COMPACTED TO 95 PERCENT STANDARD PROCTOR DENSITY AS PER ASTM-D698, AT A FIELD MOISTURE WITHIN ± 3 PERCENT OF OPTIMUM, ON SITE SOILS FREE OF ORGANICS AND DELETERIOUS
- MATERIALS AND SATISFYING THE SPECIFICATIONS PROVIDED ABOVE MAY BE STOCKPILED AND USED AS STRUCTURAL FILL
 SUBGRADE SHALL BE PROOF ROLLED WITH A HEAVILY LOADED DUMP TRUCK AND APPROVED BY THE GEOTECHNICAL ENGINEER PRIOR TO PLACING FILL FOUNDATIONS, PAVING, ETC., ANY AREAS SHOWING SIGNS OF PUMPING, RUTTING, OR ANY UNSUITABLE (ORGANIC, SOFT, WET, LOOSE) MATERIAL FOUND IN PLACE SHALL BE UNDERCUT AND REPLACED, OR MUISTURE CONDITIONED AND COMPACTED TO THE SPECIFIED DENSITY AND MOISTURE CONTENT
- IN TACKE SHALL BE DISTRICTED TO THE MANDICAP PARKING AREAS SHALL NOT EXCEED 2.0% GRADE IN ANY DIRECTION. THE SLOPE IN ALL HANDICAP ACCESS ROUTES SHALL NOT EXCEED 5.0% GRADE IN THE DIRECTION OF TRAVEL AND 2.0% CROSS SLOPE. HANDICAP RAMPS SHALL NOT EXCEED 1:12 SLOPE IN THE DIRECTION OF TRAVEL AND 2.0% CROSS SLOPE. HANDICAP RAMPS SHALL NOT EXCEED 1:12 SLOPE IN THE DIRECTION OF TRAVEL AND 2.0% CROSS SLOPE. HANDICAP RAMPS SHALL SLOPE AWAY FROM THE BUILDING(S) AT LEAST 1.0%. THE FINISHED GRADE SHALL SLOPE AWAY FROM THE BUILDING(S) AT LEAST 1.0%. THE FINISHED GRADE SHALL SLOPE AWAY FROM THE BUILDING FINISHED GRADE IS ABOVE THE FINISHED FLOR FLOWNING. CONTRACTOR SHALL NOT PLEE PRINCIPED AND SHALL BOOKED AND SHALL BUTCHED FROM THE BUILDING FINISHED GRADES ARE SHOWN ON THIS PLAN. CONTRACTOR SHALL MAKE THE APPROPRIATE HOLDDOWNS FOR SUBGRADE ELEVATIONS.
- CONTRACTOR SHALL PROVIDE FOR PERSONNEL AND VEHICULAR PROTECTION AT ANY OPEN EXCAVATIONS IN ACCORDANCE WITH 29 CFR PART
- 1926 AS WELL AS ANY REQUIREMENTS FOR EXCONATIONS GREATER THAN FOUR (4) FEET IN DEPTH.

 13. CONTRACTOR SHALL BE RESPONSIBLE FOR EXCONATIONS GREATER THAN FOUR (4) FEET IN DEPTH.

 13. CONTRACTOR SHALL BE RESPONSIBLE FOR SHORING ADJACENT TO EXISTING STRUCTURES AND UNDERGROUND UTILITIES DURING ALL

 EXCANATION OPERATIONS. TYPE OF SHORING AND PROCEDURE TO BE FOLIOWED MAY BE SUBJECT TO THE ENGINEER'S REVIEW BUT THE

 STRUCTURAL ADEQUACY OF THESE SYSTEMS, AS WELL AS DAMAGES TO THE EXISTING FACILITIES, ARE THE RESPONSIBILITY OF THE
- 14. COMPACTION TESTS SHALL BE TAKEN AT THE RECOMMENDATION OF THE ON-SITE GEOTECHNICAL ENGINEER, BUT AT A MINIMUM EVERY 2,500 SQUARE FFFT OF AREA PER R" LIFT
- 15, COMPACTION WITHIN LIMITED SPACES (I.E. MANHOLES, INLETS, UTILITY TRENCHES) SHOULD BE BACKFILLED AND COMPACTED SYSTEMATICALLY, AT THE DIRECTION OF THE ON-SITE GEOTECHNICAL ENGINEER: STONE BACKFILL SHALL BE INSTALLED IN 12" LOOSE LIFTS AND COMPACTED WITH 6-8 PASSES
- OF A VIBRATORY COMPACIOR.

 THE CONTRACTOR, PREVENT SURFACE WATER AND GROUND WATER FROM ENTERING EXCAVATIONS, FROM PONDING ON PREPARED SUBGRADES, AND FROM PLODDING PROJECT SITE AND SURROUNDING AREA. PROTECT SUBGRADES FROM SOFTENING, UNDERWINING, WASHOUT, AND DAMAGE BY RAIN OR WATER ACCUMULATION. REPOUTE SURFACE WATER RUNOFF AWAY FROM EXCAVATED. AREAS. DO NOT ALLOW WATER TO ACCUMULATE IN EXCAVATIONS. DO NOT USE EXCAVATED TRENCHES AS TEMPORARY DRAINAGE DITCHES. INSTALL A DEWATERING SYSTEM TO KEEP SUBGRADES DRY AND CONVEY GROUND WATER AWAY FROM EXCAVATIONS. MAINTAIN UNTIL DEWATERING IS NO LONGER
- 17. CONTRACTOR SHALL ENSURE POSITIVE DRAINAGE IS MAINTAINED THROUGHOUT CONSTRUCTION. PONDING AND STANDING WATER SHALL BE KEPT
- 18. A GEOTECHNICAL REPORT IS AVAILABLE. ALL EARTHWORK SHALL BE PERFORMED IN ACCORDANCE WITH THE GEOTECHNICAL REPORT FROM GEOCON, INC. REPORT NUMBER IS DL 2635-21.]

 19. NO MATERIALS CONTAINING RED CLLY ARE ALLOWED. IN THIS LOCATION.

 20. ANY BORROW MATERIALS IN THIS LOCATION MUST BE PRE-APPROVED BY THE GULF SHORES BUILDING DEPARTMENT PRIOR TO PLACEMENT.

TRAFFIC CONTROL NOTES:

- 1. THE CONTRACTOR SHALL ESTABLISH AND MAINTAIN TRAFFIC CONTROL DEVICES IN ACCORDANCE WITH THE LATEST EDITION AND REVISION OF PART VI OF 1. THE CONTRACTOR SHALL ESTABLISH AND MAINTAIN TRAFFIC CONTROL DEVICES IN ACCORDANCE WITH THE LAIEST EDITION AND TRAFFIC MAINT OF THE FORENCE OWNED TRAFFIC CONTROL PLAN FOR ALL CONSTRUCTION WITHIN WORK AREAS SHOWN AND DESCRIBED IN PART VI OF THE MUTCO.

 2. PERMANENT ROUDANT SIGNS OR TEMPORARY CONSTRUCTION SIGNS WHICH ARE NOT APPLICABLE OR INA-PPROPRIATE FOR THE CURRENT CONDITIONS SHALL BE COVERED OR REMOVED.

 3. THE DIMENSIONS SHOWN OR DESCRIBED FOR LOCATING CONSTRUCTION SIGNS ARE NOMINAL THE ACTUAL DIMENSIONS SHALL BE ADJUSTED TO BEST FIT LOCAL CONDITIONS AND PROVIDE MAXIMUM VISIBILITY.

 4. IF TRAFFIC CONTROL DEVICES ARE NECESSARY FOR PROVER WARNING AND TRAFFIC CONTROL AFTER SUNSET, THEN AS A NINMUM, TYPE "B" WARNING AND TRAFFIC CONTROL DEVICES ARE NECESSARY FOR PROVER WARNING AND TRAFFIC CONTROL AFTER SUNSET, THEN AS A NINMUM, TYPE "B" WARNING

- LIGHTS SHALL BE PLACED ON THE FIRST WARNING SIGN AND CHANNELIZING DRUM AND TYPE "A" REFLECTIVE SHEETING SHALL BE REQUIRED ON ALL
- SHAZAROUS CONDITIONS ON OPEN ROADWAYS SUCH AS PAVEMENT DROP-OFFS IN EXCESS OF 2°; CONSTRUCTION MATERIALS, VEHICLES, OR EQUIPMENT STORED OR PLACED WITHIN THE ROADWAY RIGHT-OF-WAY; AND OPEN TRENCHES ACROSS OR NEAR THE ROADWAY SHALL NOT BE ALLOWED UNLESS THE CONTRACTOR IS ON SITE AND MORRHING, AND PROPER TRAFFIC CONTROL MEASURES ARE BBING TAKEN.

 THE CONTRACTOR SHALL KEEP OPEN ROADWAYS CLEAN AND FREE OF CONSTRUCTION DEBRIS, DIRT, LOOSE GRAVEL OR OTHER MATERIAL THAT MAY
- CAUSE HAZARDOUS DRIVING CONDITIONS.
 7. TRAFFIC CONTROL DEVICES SHALL MEET THE STANDARD MATERIAL AND INSTALLATION REQUIREMENTS SPECIFIED IN THE CURRENT EDITION OF THE
- AL.D.O.T. STANDARD SPECIFICATIONS FOR HIGHWAY CONSTRUCTION.
- ROADWAYS AND DRIVEWAYS SHALL REMAIN OPEN DURING CONSTRUCTION
- CHANNELIZING DEVICES SHALL BE PLACED AT 10' ON CENTER ALONG MINIMUM 20' RADII TO CHANNELIZE TRAFFIC INTO AND OUT OF INTERSECTING ROAD AND DRIVES WITHIN AREAS WHERE CHANNELIZING DEVICES ARE REQUIRED. TEMPORARY REGULATORY SIGNS SHULH AS STOP SIGNS AND YIELD SIGNS SHULL BE PLACED AS NO EXCESSARY FOR PROPER TRAFFIC CONTROL IN ACCORDANCE WITH THE MUTCO.

EROSION CONTROL NOTES:

- SITE EROSION CONTROL MEASURES SHALL BE IN ACCORDANCE WITH ALL FEDERAL, STATE, AND LOCAL LAWS, CODES, AND REGULATIONS. THE CONTRACTOR SHALL BE RESPONSIBLE FOR OUTANING A "NOTICE OF REGISTRATION"(NOR) FROM ADEM. THE CONTRACTOR SHALL BE RESPONSIBLE FOR ALL MONTRORNER, INSPECTIONS, ETC. TO ENSURE THE OWNER THAT THE STIE S AT ALL TIMES IN ACCORDANCE WITH ADEM RULES & REGULATIONS, DOCUMENTATION OF INSPECTIONS BY A CL. LOR O.C.P. SHALL BE MAINTAINED BY THE CONTRACTOR AND PROVIDED TO THE OWNER AT HIS/HER REQUEST. ANY AND ALL FEES, FINES, ETC., SHALL BE THE RESPONSIBILITY OF THE CONTRACTOR ALL EROSION CONTROL DEVICES SHALL BE PROPERTY MANIFAMED DURING THE CONSTRUCTION PROCESS AND UNITL ALL DISTURBED AREAS HAVE BEEN PERMANENTLY STABILIZED. ALL EROSION CONTROL DEVICES SHALL BE AT NO ADDITIONAL COST TO THE OWNER.

 ROSION CONTROL DEVICES SHOWN ON THESE PLANS ARE A MINIMUM. ADDITIONAL DEVICES SHALL BE INSTALLED AS REQUIRED TO PREVENT SILTATION, EROSION AND OTHER DEGRADATION OR POLLUTION TO THE SITE OR ADJACENT PROPERTIES, STREAMS, DITCHES, AND PUBLIC ROADWAYS.

- ROADWAYS.

 EROSION CONTROL DEVICES SHALL INCLUDE, BUT NOT LIMITED, TO THE FOLLOWING DEVICES: SILT FENCING, BRUSH BERMS, SEDIMENT BASINS, DETENTION PONDS, STRAW WATRLES, CHECK DAMS, FILTER BERMS, JUTE MATTING, VEGETATIVE FILTER STRIPS, TURF REINFORCEMENT MAT,
- DIVERSION BERMS, EIC.
 THE CONTRACTOR SHALL BE RESPONSIBLE FOR MAINTAINING ALL EROSION CONTROL DEVICES IN GOOD OPERATING CONDITION DURING ALL LAND
 DISTURBING ACTIVITIES. THIS RESPONSIBILITY SHALL INCLUDE THE CLEANUP AND/OR REPAIRS TO THE DEVICES AT NO ADDITIONAL COST TO THE
- 7. FROSION CONTROL DEVICES SHALL BE MONITORED AND MAINTAINED UNTIL THE SITE HAS BEEN PERMANENTLY STABILIZED AND AFTER EACH WINFALL GREATER THAN 0.5 INCHES IN A 24 HOUR PERIOD, ANY WIND GUSTS GREATER THAN 25 MPH, AND ANY SUSTAINED WINDS GREATER
- RANFALL GREATER THAN 0.5 INCHES IN A 24 HOUR PERIOD, ANY WIND GUSTS GREATER THAN 25 MPH, AND ANY SUSTAINED WINDS GREATER THAN 20 MPH IN A 24 HOUR PERIOD.

 8. AFTER ALL LAND DISTURBANCE ACTIVITIES HAVE CEASED AND AFTER ALL DISTURBED AREAS HAVE BEEN PERMANENTLY STABILIZED, THE EROSION CONTROL DEVICES SHALL BE REMOVED BY THE CONTRACTOR AND THE AREA CLEAVED AND DRESSED.

 9. DEWATERING OPERATIONS MAY NOT BE DISCHARGED IN A MANNER THAT CAUSES EROSION OF THE SITE OR POLLUTION TO ADJACENT PROPERTIES, STEAMS, DITCHES, OR PUBLIC ROJONWAYS.


 10. A GRAWELD ACCESS DRIVE OF SUFFICIENT SIZE SHALL BE AT EACH SITE ENTRANCE/EXIT TO PREVENT TRACKING OF DIRT AND SEDIMENT ONTO PUBLIC OR PROMOTE ROJOWAYS. IF SEDIMENT RESCHES THE ROJOWAY, THEN IT MUST BE CLEANED AT THE END OF EACH WORKDAY.

 11. ALL LAND DISTURBANCE ACTIVITIES SHALL BE CONDUCTED IN A LOGICAL SEQUENCE TO MINIMIZE THE EXPOSURE OF BARE AREAS AT ANY ONE THE

- 12. ALL DISTURBED AREAS LEFT INACTIVE FOR MORE THAN 13 DAYS SHALL BE SEEDED AND MULCHED IN ACCORDANCE WITH ALDOT SPECIFICATIONS SECTION 652 AND 656.
- 13. ALL PREVIOUSLY GRADED AREAS SHALL RECEIVE 4 INCHES OF TOPSOIL AND PERMANENT GRASSING UNLESS OTHERWISE INDICATED ON THE
- 14. PRIOR TO SITE CLEARING, ALL PERIMETER SILT FENCING, BRUSH BERMS, ETC. AND GRAVELED ACCESS DRIVES SHALL BE INSTALLED.

 15. GOOD MOUSEKEEPING PRACTICES AND PREVENTATIVE MAINTENANCE SHALL BE PERFORMED ON SITE DALLY TO PREVENT POLLUTION SOURCES FROM CONTACTING STORMWATER AND GROUND WATER. THIS INCLUDES, BUT IS NOT LIMITED TO: EQUIPMENT INSPECTION FOR LEAKS OF HAZARDOUS MATERIALS, PICKUP AND PROPER DISPOSAL OF MASTE MATERIALS TO APPROVED DISPOSAL SITES, STORING CONTINUESS AND BAGS
 AWAY FROM TRAFFIC ROUTES, PUBLICIBING POLILUTION PREVENTION CONCEPTS THROUGH POSTERS, WASHING EQUIPMENT AND VEHICLES AT
- APPROVED WASHING LOCATIONS, AND USING ONLY WARTER (NO DETERGENTS) FOR WASHING ACTIVITIES.

 16, AT A MINIMUM, THE EROSION CONTROL DEVICES SHOWN ON THESE PLANS SHALL BE INSTALLED. ADDITIONAL MEASURES MAY BE REQUIRED AND SHALL BE INSTALLED LYON ADDITIONAL SILITATION, EROSION, AND OTHER DEGRADATION OR POLLUTION TO THE SITE OR ADJACANT PROPERTIES, STREAMS, DITCHES, AND PUBLIC ROADMAYS NOT MITIGATED OR UNFORESEEN BY THIS SET OF PLANS.

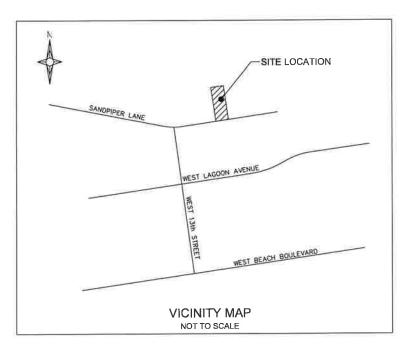

ISSUED FOR **REVIEW**

R	EVISIONS		
A	ISSUED FOR REVIEW	10/25/2021	
В	ADDRESSING CITY COMMENTS	12/29/2021	



LIER ENGINEERING COMPANY 1290 MAIN STREET, SUITE E DAPHNE, AL 36526 PH: (251) 978-9779

NOT VALID WITHOUT THE DATED SIGNATURE AND SEAL OF AN ALABAMA LICENSED ENGINEER. ALABAMA LICENSED ENGINEER: CHRISTOPHER JAY LIEB, P.E. LICENSE NUMBER 31204 ALABAMA CERTIFICATE OF AUTHORIZATION NUMBER: 4938


SANDPIPER NOTES GULF SHORES, AL

OWNER: BEARDED TURKEY, LLC JOB NUMBER DRAWN BY: JLG DATE: 9/2/2021 SCALE: AS SHOWN SHEET NUMBER C1.0CHECKED BY: CJL APPROVED BY: CJL ENGR: CJL OF 8





1. SEE SHEET C1.0 FOR ALL GENERAL NOTES.

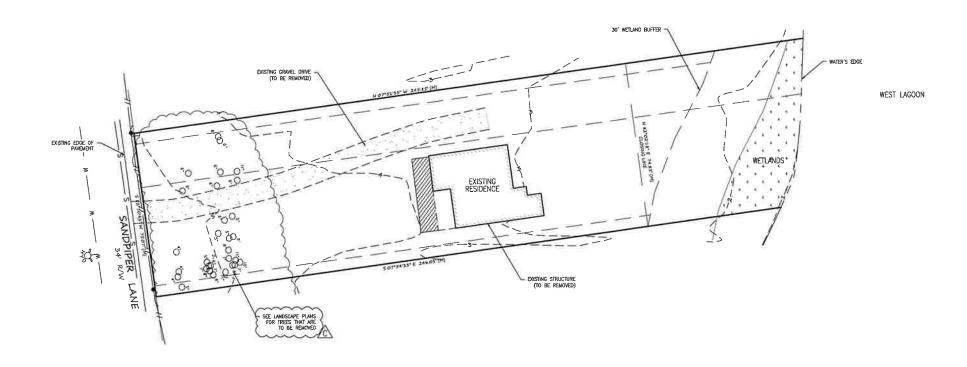

ISSUED FOR REVIEW

W.	ISSUED FOR REVIEW	10/25/2021	
3	ADDRESSING CITY COMMENTS	12/29/2021	
	ADDRESSING CITY COMMENTS	1/18/2022	



LIEB ENGINEERING COMPANY 1290 MAIN STREET, SUITE E DAPHNE, AL 36526 PH: (251) 978-9779

JOB NUMBER


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Н	NOT VALID WITHOUT THE DATED SIGNATURE AND SEAL OF AN ALABAMA LICENSED ENGINEER.
	NOT VALID WITHOUT THE DATED SIGNATURE AND SEAR OF MY METALLINE ENGINEERS
7	ALABAMA LICENSED ENGINEER: CHRISTOPHER JAY LIEB, P.E. LICENSE NUMBER 31204
-	ALABAMA CERTIFICATE OF AUTHORIZATION NUMBER: 4938
- 1	· · · · · · · · · · · · · · · · · ·

DRAWN BY: <u>JLG</u> DATE: <u>9/2/2021</u> SCALE: <u>1"=20'</u>

CHECKED BY: CJL APPROVED BY: CJL ENGR: CJL

	SANDPIPER			
R.	EXISTING CONDITION	S & DEMOLITION PLAN		
	GULF SHORES, AL			
	OWNER: BEARDED 1	URKEY, LLC		
	SHEET NUMBER		00.0	
	2 OF 8		C2.0	C

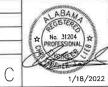

SITE_DATA:

2. ZONING:
2. ZONING:
3. TOTAL AREA:
4. DISTURBED AREA:
5. SMALLEST LOT SIZE:
6. LARGEST LOT SIZE:
7. TOTAL UNITS:
8. BUILDING HEIGHT:

9. UNEAR FEET IN STREETS: 10. IMPERVIOUS SURFACE:

11. DENSITY: 12. OPEN SPACE: 13. USEABLE OPEN SPACE: 14. SETBACKS:

COTTAGE SUBDIMISION
BT-1
0.52± AC, (22,492 S.F.)
0.32± AC, (13,936± S.F.)
1,512 S.F.
2,062 S.F.
5 LOTS
40'-7 ½ & 38'-7 ½
(2 HABITABLE STORIES ABOVE PARKING UNDERNEATH)
23 L.F.
0.16± AC, (6,790 S.F.)(30,77%)
814 S.F. CONCRETE
5,976 S.F. BUILDING COVERAGE/0.14 AC/26,92%
10.40 UNITS PER ACRE
0.19± AC, (8,247 S.F.) (36.54%)
0.19± AC, (8,247 S.F.) (36.54%)
FRONT 0'-5' (SEE PLANS)
SIDE 0'-5' (SEE PLANS)
REAR 0'-5' (SEE PLANS)

<u>LEGEND</u>

BRICK PAVERS

STANDARD DUTY ASPHALT PAVING

CONCRETE PAVING EXISTING ASPHALT PAVING

NOTES:

- 1. SEE SHEET C1.0 FOR ALL GENERAL NOTES,

 2. EACH UNIT IS 4 BEDROOMS W/ 4 PARKING SPACES AT
 LEAST 10 x20' ARE PROVIDED UNDER EACH COTTAGE.


 3. THE REFUSE CANS WILL BE STORED UNDER EACH
 COTTAGE AND BE ROLLED OUT TO THE ROAD DURING
 NORMAL PICKUP DAY.

 4. ROLL—OUT CONTAINERS MAY NOT BE PLACED ON
 SANDPIPER LANE

 5. ALL COMMON LAND AREAS AND FACILITIES SMALL BE
 OWNED AND MAINTAINED BY A PROPERTY OWNER'S
 ASSOCIATION, IN ACCORDANCE WITH OWNERSHIP AND
 MANAGEMENT OF COMMON OPEN SPACES, AND SHALL
 BE RESTRICTED IN THEIR USE TO PROPERTY OWNERS
 AND THEIR GUESTS. AND THEIR GUESTS.





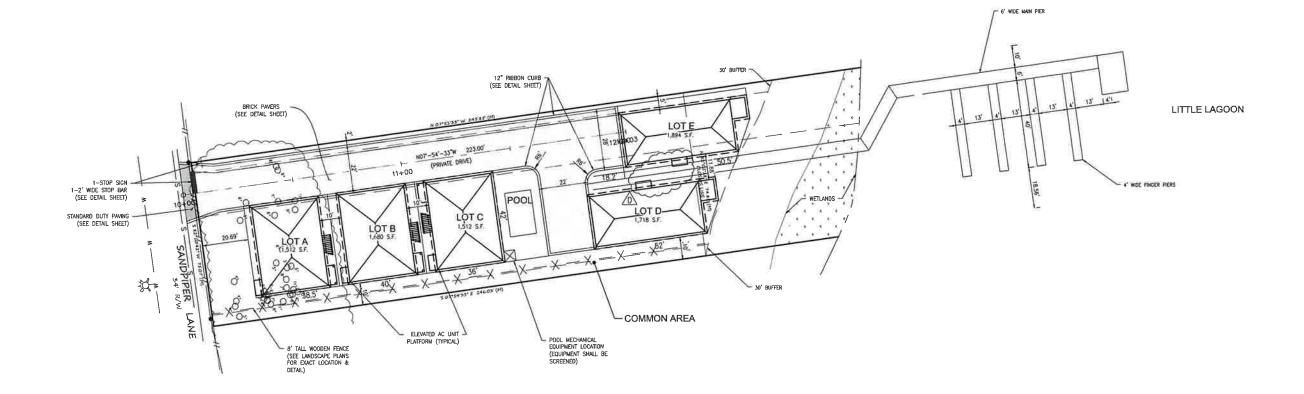

ISSUED FOR REVIEW

ISSUED FOR REVIEW	10/25/2021	
ADDRESSING CITY COMMENTS	12/29/2021	
ADDRESSING CITY COMMENTS	1/18/2022	
ADDRESSING CITY COMMENTS	1/19/2022	
	ADDRESSING CITY COMMENTS ADDRESSING CITY COMMENTS	ADDRESSING CITY COMMENTS 12/29/2021 ADDRESSING CITY COMMENTS 1/18/2022



LIEB ENGINEERING COMPANY 1290 MAIN STREET, SUITE E DAPHNE, AL 36526 PH: (251) 978-9779

JOB NUMBER

2021-059

	NOT VALID WITHOUT THE DATED SIGNATURE AND SEAL OF AN ALABAMA LICENSED ENGINEER.
И	ALABAMA LICENSED ENGINEER: CHRISTOPHER JAY LIEB, P.E. LICENSE NUMBER 31204
Ė	ALABAMA CERTIFICATE OF AUTHORIZATION NUMBER: 4938

CHECKED BY: CJL APPROVED BY: CJL ENGR: CJL

DRAWN BY: JLG


DATE: 9/2/2021 SCALE: 1"=20'

	SANDPIPER		
Ŕ.	SITE PLAN		
	GULF SHORES, AL		
	OWNER: BEARDED TURKEY, LL	C	
	SHEET NUMBER	07.0	
	3 OF 8	C3.0	\cup




STORM DRAINAGE NARRATIVE:

STORMWATER RUNOFF WILL NOT INCREASE DUE TO THE DEVELOPMENT. ACCORDING TO THE GEOTECHNICAL REPORT, THE INFLITATION RATE OF THE SITE IS 36 IN/HR. CURRENILY THERE IS NO STORMWATER LEAVING THE SITE. POST DEVELOPMENT RUNOFF WILL BE CONTAINED ON SITE. THE ROADWAY AND SIDEWALK AREA ARE SLATED TO BE CONSTRUCTED OF PERVIOUS PAVERS. THE STORMWATER THAT FALLS ON THIS AREA WILL PERCOLATE INTO THE GROUND, THE STORMWATER THAT FALLS ON THIS AREA WILL PERCOLATE INTO THE GROUND. THE CONTAGES WILL BE DIRECTED TO LANDSCAPE AREAS. THIS WATER WILL PERCOLATE INTO THE GROUND. THE CONCRETE AROUND THE POOLS AND SIDEWALK WILL BE SLOPED TO THE LANDSCAPE AREAS. THIS WATER WILL PERCOLATE INTO THE GROUND AS WELL.

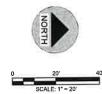

NOTES:

1. SEE SHEET C1.0 FOR ALL GENERAL NOTES.

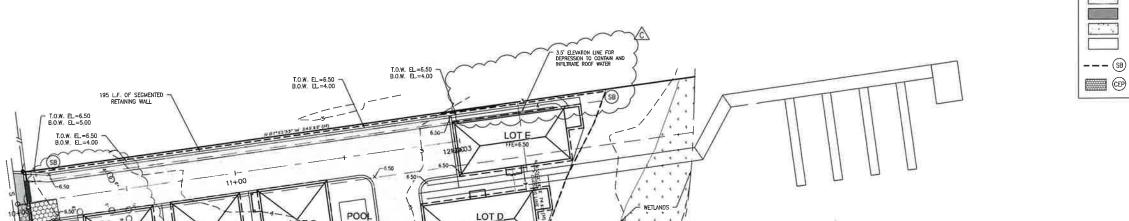

LEGEND STANDARD DUTY ASPHALT PAVING CONCRETE PAYING EXISTING ASPHALT PAVING --- (SB) SILT FENCE, TYPE "A" CEP CONSTRUCTION EXIT PAD

> ISSUED FOR REVIEW

REVISIONS		
A	ISSUED FOR REVIEW	10/25/2021
В	ADDRESSING CITY COMMENTS	12/29/2021
C	ADDRESSING CITY COMMENTS	01/19/2022

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LIEB ENGINEERING COMPANY 1290 MAIN STREET, SUITE E DAPHNE, AL 36526 PH: (251) 978-9779

JOB NUMBER

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NV	NOT VALID WITHOUT THE DATED SIGNATURE AND SEAL OF AN ALABAMA LICENSED ENGINEER ALABAMA LICENSED ENGINEER: CHRISTOPHER JAY LIEB, P.E. LICENSE NUMBER 31204 ALABAMA CERTIFICATE OF AUTHORIZATION NUMBER: 4938
"F	ALABAMA CERTIFICATE OF AUTHORIZATION NUMBER: 4938

CHECKED BY: CJL APPROVED BY: CJL

DRAWN BY: JLG

DATE: 9/2/2021 SCALE: 1"=20'

ENGR: CJL

	SANDPIPER			
R.	GRADING & DRAINAG	GE PLAN		
	GULF SHORES, AL			
	OWNER: BEARDED T	URKEY, LLC		
	SHEET NUMBER		040	
	4 OF 8		C4.0	




LEGEND BRICK PAVERS STANDARD DUTY ASPHALT PAVING CONCRETE PAVING EXISTING ASPHALT PAYING PROPOSED TAPPING SLEEVE & VALVE W/ THRUST BLOCK PROPOSED GRAVITY SEWER LINE (\$) PROPOSED SEWER MANHOLE PROPOSED SEWER LATERAL SERVICE PROPOSED SEWER CLEANOUT



NOTES:

1. SEE SHEET C1.0 FOR ALL GENERAL NOTES.

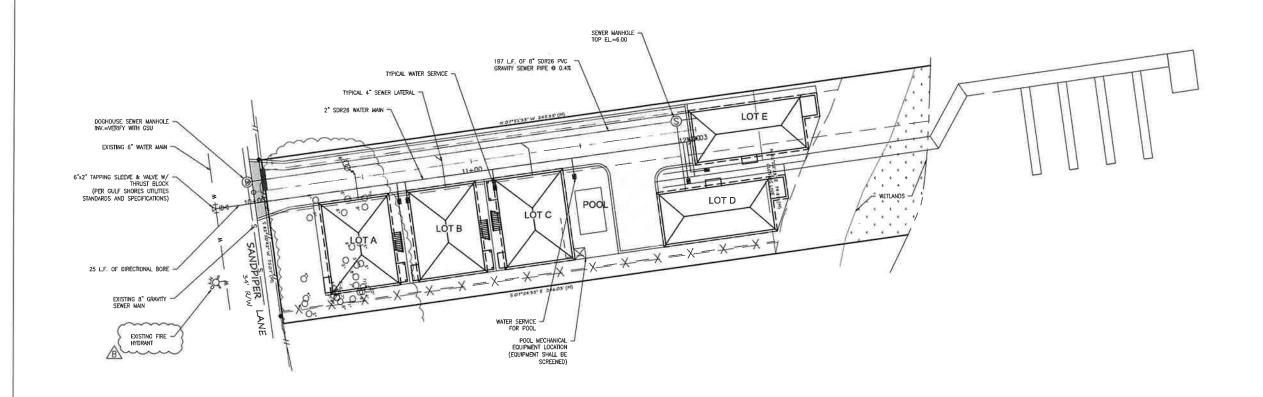

ISSUED FOR **REVIEW**

ISSUED FOR REVIEW	10/25/2021	
ADDRESSING CITY COMMENTS	12/29/2021	
	ISSUED FOR REVIEW ADDRESSING CITY COMMENTS	ADDRESSING CITY COMMENTS 12/29/2021

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LIEB ENGINEERING COMPANY 1290 MAIN STREET, SUITE E DAPHNE, AL 36526 PH: (251) 978–9779

JOB NUMBER

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	NOT VALID WITHOUT THE DATED SIGNATURE AND SEAL OF AN ALABAMA LICENSED ENGINEER.
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DRAWN BY: <u>JLG</u> DATE: <u>9/2/2021</u> SCALE: <u>1"=20"</u>

CHECKED BY: CJL APPROVED BY: CJL ENGR: CJL

ľ	SANDPIPER		
₹.	UTILITY PLAN		
	GULF SHORES, AL		
Ì	OWNER: BEARDED T	URKEY, LLC	
	SHEET NUMBER	C5 0	R
	5 OF 8	00.0	

	ABAGA
	No. 31204
)	12/29/2021

20 15 15 10 10 0.00% 197 LF. OF 8" S.S. 0 EXISTING EDGE OF F -5 -5 3.25 12+00 12+50 11+50 11+00 10+00 10+50

PROFILE SCALE:
HORIZONTAL: 1"=30"
VERTICAL: 1"=3"

ISSUED FOR REVIEW

REVISIONS			
A	ISSUED FOR REVIEW	10/25/2021	
В	ISSUED FOR REVIEW ADDRESSING CITY COMMENTS	12/29/2021	
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П	NOT VALID WITHOUT THE DATED SIGNATURE AND SEAL OF AN ALABAMA LICENSED ENGINEER
	ALABAMA LICENSED ENGINEER: CHRISTOPHER JAY LIEB, P.E. LICENSE NUMBER 31204
IJ	ALABAMA CERTIFICATE OF AUTHORIZATION NUMBER: 4938
·	ALADAMA CENTITIONE OF AUTHORIZATION NOMBER. 1999


1	SANDPIPER		
	PLAN & PROFILE		
	GULF SHORES, AL		
	OWNER: BEARDED TUR	RKEY, LLC	
	SHEET NUMBER	C6.0	
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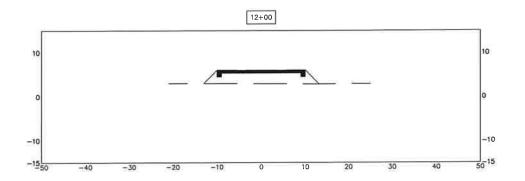
	A BAM
	No. 31204 PROFESSIONAL
В	12/29/2021

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79	JOB NUMBER	DRAWN BY: JLG	DATE: 9/2/2021 SCALE: AS SHOWN	SHEET NUM
	2021-059	CHECKED BY: CJL	APPROVED BY: CJL ENGR: CJL	6 OF


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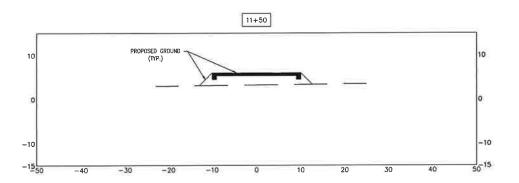
1. SEE SHEET C1.0 FOR ALL GENERAL NOTES,



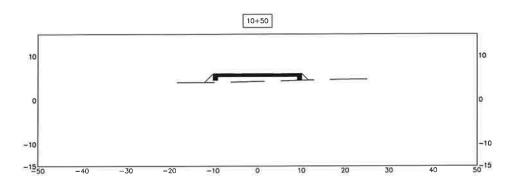

SECTION SCALE: HORIZONTAL: 1"=10' VERTICAL: 1"=10'



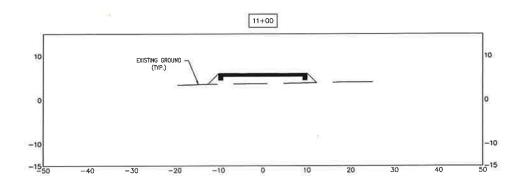

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A: I	ISSUED FOR REVIEW ADDRESSING CITY COMMENTS	10/25/2021	
3	ADDRESSING CITY COMMENTS	12/29/2021	

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JOB NUMBER

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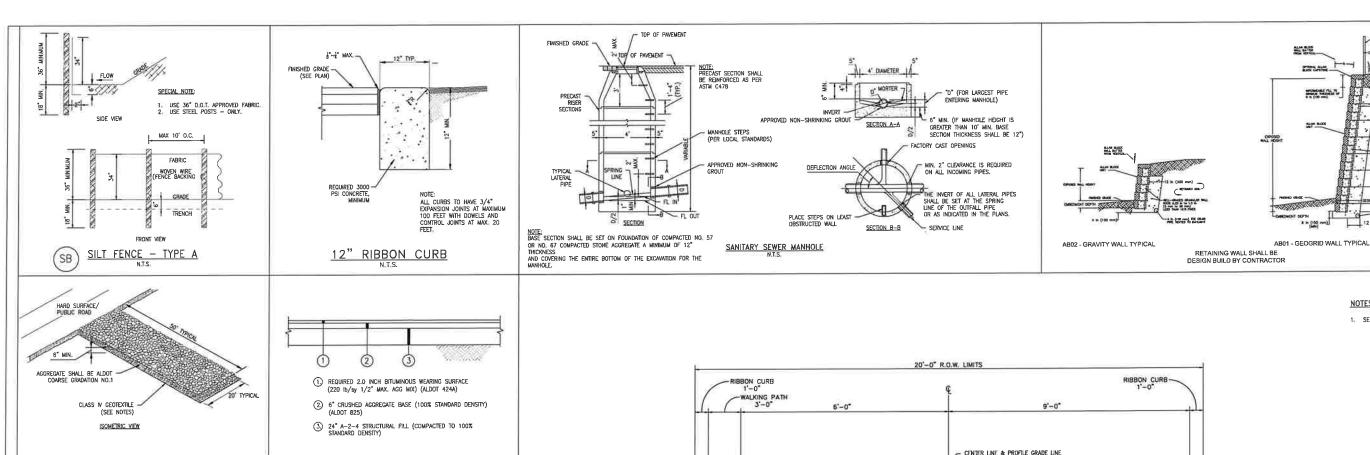
NOT VALID WITHOUT THE DATED SIGNATURE AND SEAL OF AN ALABAMA LICENSED ENGINEER.
ALABAMA LICENSED ENGINEER: CHRISTOPHER JAY LIEB, P.E. LICENSE NUMBER 31204
ALABAMA CERTIFICATE OF AUTHORIZATION NUMBER: 4938
ALABAMA CERTIFICATE OF AUTHORIZATION NUMBER. 4508

DRAWN BY: <u>JLG</u> DATE: <u>9/2/2021</u> SCALE: <u>1"=10"</u>

CHECKED BY: CJL APPROVED BY: CJL ENGR: CJL

	SANDPIPER		
R.	SECTIONS		
	GULF SHORES, AL		
- 1	OWNER: BEARDED TURKEY, LLC		
	SHEET NUMBER	07.0	
	7 OF 8	C/.U	

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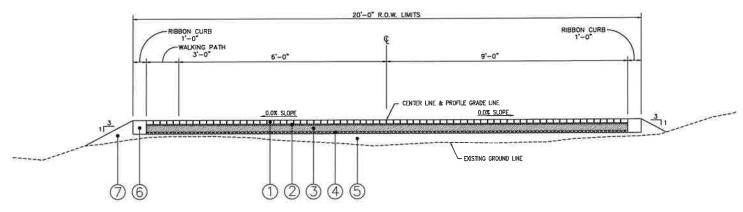
1. SEE SHEET C1.0 FOR ALL GENERAL NOTES.

42" TALL DECORATIVE FENCE (BY OTHERS)


1 1 () =1 CHEATING AND CONT.

GEOGRID REINFORCEMENT TYPE AND LENGTH VARIES PER WALL DESIGN

In (100 mm) HEEL DRAIN



ISSUED FOR **REVIEW**

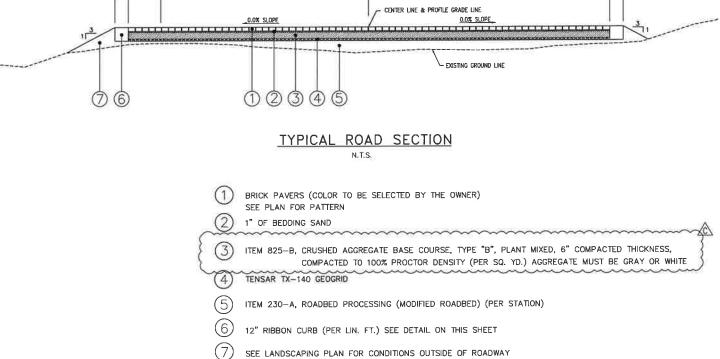

Α	ISSUED FOR REVIEW	10/25/2021	
В	ADDRESSING CITY COMMENTS	12/29/2021	
С	ADDRESSING CITY COMMENTS	1/18/2022	
D	ADDRESSING CITY COMMENTS	1/19/2022	

50' MINIMUM

ELEVATION

A STRADUZED PAD OF CRUSHED STONE SPREAD OVER FILTER FABRIC SHALL BE LOCATED WHERE TRAPFIC WILL BE ENTERING OR LEAVING A CONSTRUCTION SITE TO OR FROM A PUBLIC STREET. THE STONE SHALL BE MODT GRADATION NO. 1 STONE, FILTER FABRIC SHALL BE NONWOWNEN GEOTEXTILE CLASS IV OR EQUAL.

2. THE ENTRANCE SHALL BE MANTANIED IN A CONDITION PHILL STREETS OR EXISTING PAYEMENT. THIS MAY REQUIRE PERIODIC TOP DIRESSING WITH ADDITIONAL STONE AS CONDITIONS DEMAND AND REPAIR AND/OR CLEANQUT OF ANY MEASURES USED TO TRAP SEDIMENT.

3. ALL SEDIMENT SHILLED, ROPPPED, MASHED OR TRACKED DONTO PUBLIC STREETS USED TO STREETS WIST BE REMOVED IMMEDIATELY BY STREET CLEANING (NOT FLUSHING). WHEN RECESSARY, WHELS MUST SE LEANED TO

FLUSHING). WHEN NECESSARY, WHEELS MUST BE CLEANED TO REMOVE SEDIMENT PRIOR TO ENTERING A PUBLIC STREET. WHEN

BASIN.

IF THE PAD SLOPE TOWARDS THE ROAD EXCEEDS 2%, A DIVERSION RIDGE 6" – 8" HIGH WITH 3:1 SIDE SLOPES MUST BE CONSTRUCTED ACROSS THE FOUNDATION APPROXIMATELY 15" AWAY FROM THE ROAD AND DRAIN INTO A SEDIMENT TRAP OR BASIN.

IT HIS DESIGN IS FOR SEDIMENT TRAPPING AND REMOVAL. UNDERCUT AND REPLACE UNSUITABLE SOILS FOR CONSTRUCTION TRAFFIC AS NECESSARY.

WASHING IS REQUIRED, IT SHALL BE DONE ON AN AREA STABILIZED WITH CRUSHED STONE WHICH DRAINS INTO AN APPROVED SEDIMENT

CONSTRUCTION EXIT PAD

6" MIN.

SPECIAL NOTES

(CEP)

HARD SURFACE/ PUBLIC_ROAD

CLASS IV GEOTEXTILE

STANDARD DUTY ASPHALT PAVING

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JOB NUMBER


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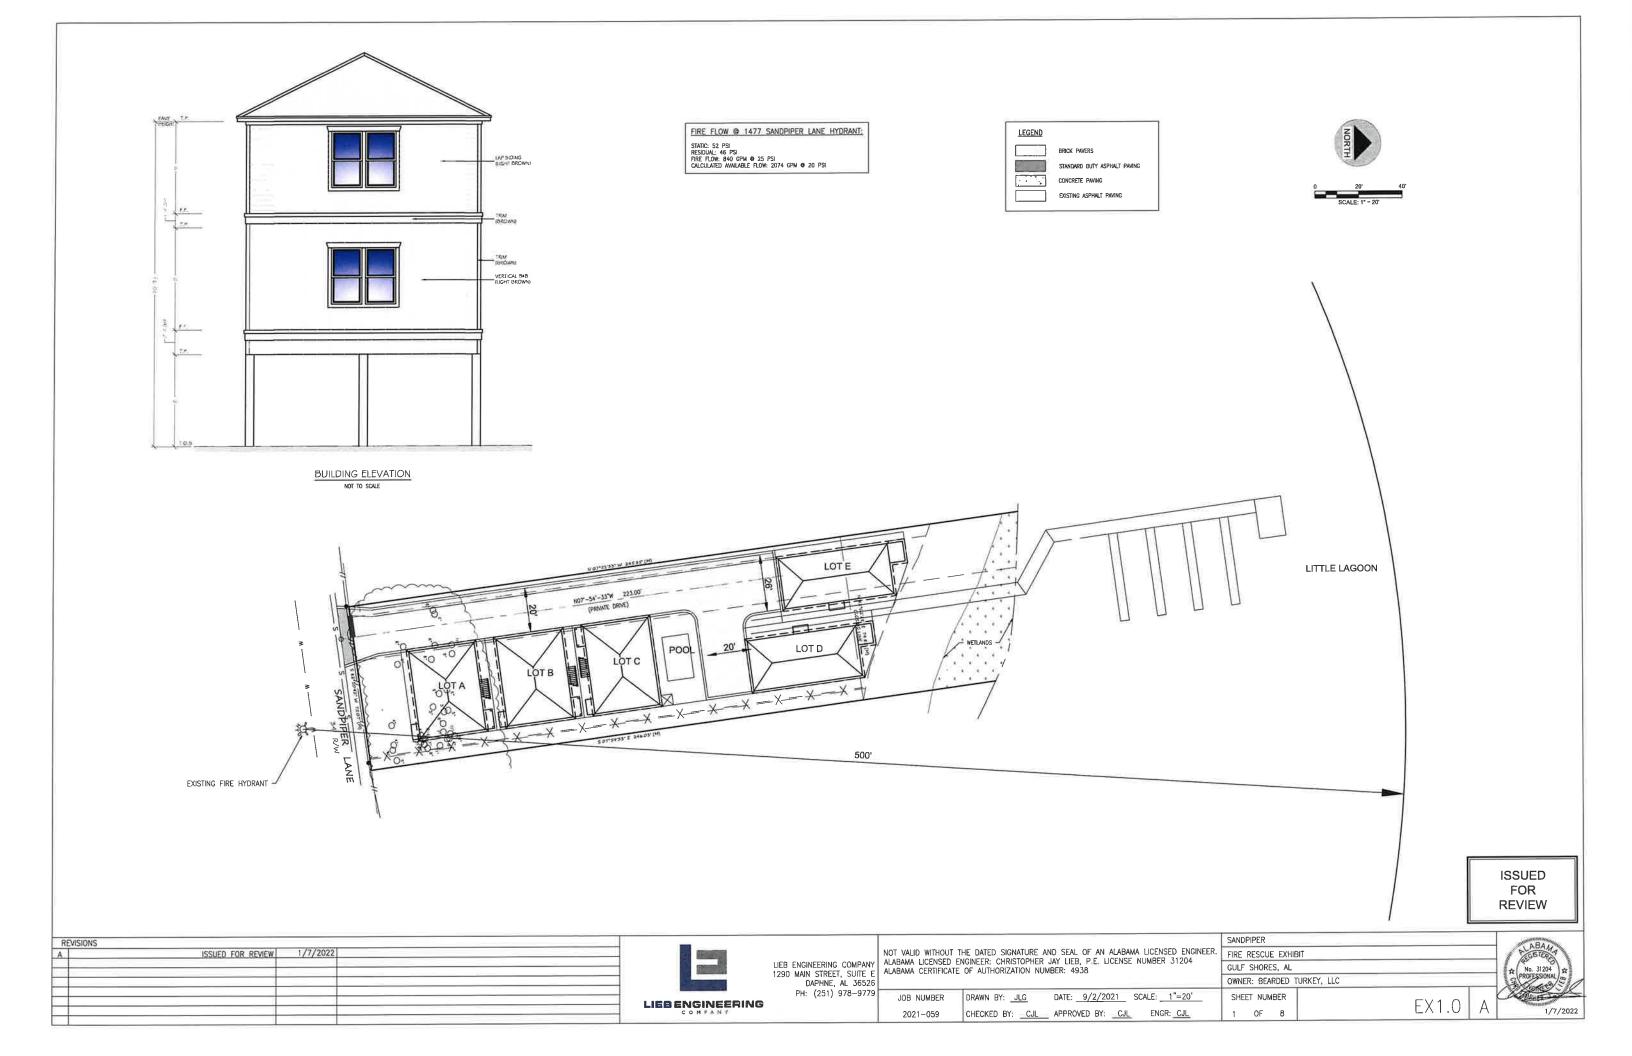
CHECKED BY: CJL APPROVED BY: CJL ENGR: CJL

DRAWN BY: JLG

DATE: 9/2/2021 SCALE: AS SHOWN

SANDPIPER DETAILS GULF SHORES, AL OWNER: BEARDED TURKEY, LLC SHEET NUMBER C8.0



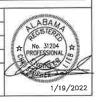

WOVEN WIRE (39" NOM. HT.)-COVERED WITH GEOTEXTILE RING FASTENERS (TOP ONLY) @ APPROX, 2' O.C. REQUIRED SIGNAGE, MIN, 6 SF 2 WIRES TWISTED TO SINGING TAUTNESS (12 GA MIN.) SILT FENCE & POST Tree Protection BURY WOVE WIRE FENCE APPROX. 3" Zone, Do FLOW Not Enter HAY BALES, CONTINUOUS @ BASE OF FENCE W/ WOODEN STAKES AS NECESSARY SILT FENCE TO BE HOLES SHALL BE PROPERLY BACKFILLED AND TAMPED WITH SOIL TO APPROXIMATE DENSITY OF EXISTING SOIL. BURIED 6"X6" INTO NATURAL GROUND

NOTES

- NOTES

 1. FENCING TO BE INSTALLED PRIOR TO CONSTRUCTION, FENCING TYPE SHALL BE SILT FENCE & HAY BALES. NO ENTRY, STORAGE, TEMPORARY PARKING, OR DISTURBANCE IS ALLOWED WITHIN THE PROTECTED AREA.

 2. THE FENCE SHALL BE ERECTED W/A MIN, DISTANCE OF 20' FROM THE TRUNKS OF HERITAGE TREES & 10' FROM ALL OTHER RETAINED TREES. IF INSTALLING UNDERGROUND UTILITIES NEAR TIREE ROOTS BECOMES A HARDSHIP, A SOIL AUGER SHALL BE USED TO TUNNEL UNDER TREE ROOTS.

 3. ALL ROOTS TO BE REMOVED DURING SITE CLEARING &/OR CONSTRUCTION SHALL BE SEVERED CLEANLY AT THE PERIMETER OF THE PROTECTED RADIUS.

 4. FOOTERS FOR WALLS SHALL END AT THE POINT WHERE LARGE ROOTS APE ENCOUNTERED. AND THE ROOTS SHALL BE RIDGED. POST HOLES AND TRENCHES LOCATED CLOSE TO RETAINED TREES SHALL BE ADJUSTED TO AVOID DAMAGE TO MAJOR ROOTS.


 5. FENCING CANNOT BE REMOVED UNTIL LAND ALTERATION, SITE CLEARING, AND CONSTRUCTION ACTIVITIES ARE COMPLETE.

 6. TIREE PROTECTION SIGNAGE TO BE A MINIMUM OF 6 SQUARE FEET READING "Tree Protection Zone, Do Not Enter"

TREE PROTECTION FENCE - GULF SHORES


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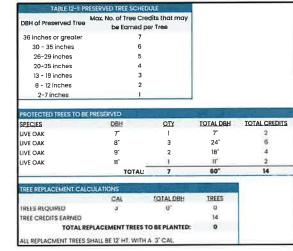
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TREE PROTECTION FENCING

- TREE PROTECTION FENCING SHALL BE A MINIMUM OF 3 FEET IN HEIGHT AND BE CONSTRUCTED USING A COMBINATION OF SILT FENCE AND HAY BALES.
 ALL TREE PROTECTION FENCING MUST COMPLY WITH CITY OF GULF SHORES ORDINANCE No. 2036 TREE PROTECTION,

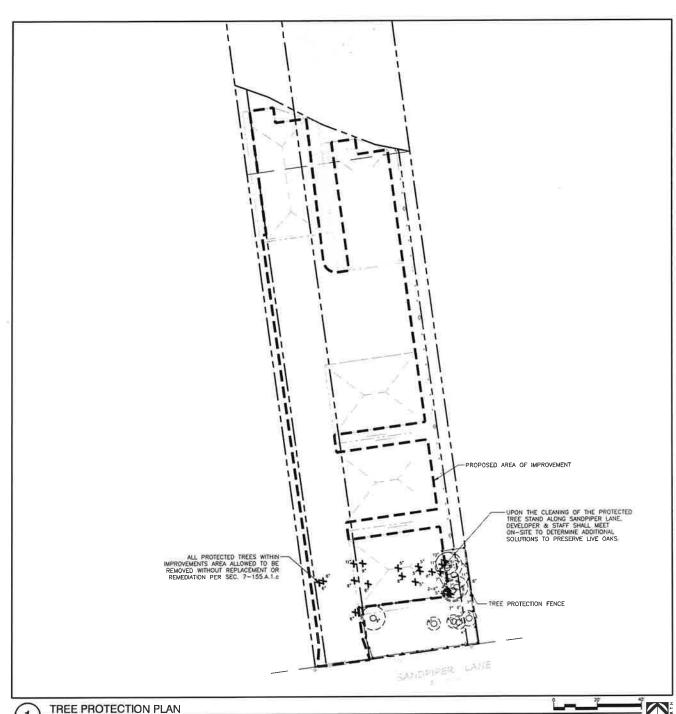



TREE PRESERVATION NOTES

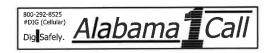TREE SURVEY DISCLAMER

ALL TREE SURVEY INFORMATION HAS BEEN PROVIDED TO LANDSCAPE ARCHITECT BY WEYGAND WILSON

TREE PRESERVATION/REMOVAL NOTES

WHERE IREES ARE INDICATED TO BE SAVED, OUR BEST PRACTICE WILL BE TO MAINTAIN NATURAL AREAS OF OVER & UNDERSTORY VEGETATION, RATHER THAN A CONTINUOUS CLEARING OF THE UNDERSTORY TO HIGHLIGHT THE TREES. WHEN THESE AREAS REMAIN AS NATURAL, THE CUMULATIVE VEGETATIVE DENSITY SHOULD CREATE SOFT POCKETS WITHIN WHOHE HOUSE SITES CAN BE NESTLED IN AND THE NATURAL BEAUTY OF THIS SITE CAN BE MAINTAINED.

TREE PROTECTION LEGEND

- + PROTECTED OAK TO BE REMOVED
- PROTECTED OAK TO REMAIN

TREE PROTECTION FENCE TREE PROTECTION ZONE





Piper Į Sand Gulf Shores,


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No.	Date	Revisions / Submissions
_	10.25.21	PERMIT SUBMITTAL
_	01.07.22	PERMIT RESUBMITTAL
	01.18.22	REVISED PER CITY COMMENTS
_	01.20.22	REVISED PER CITY COMMENTS
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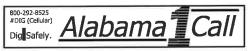
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Project Manager	/7/ CHAS
LCW	1. MARKEYE
Principal	2 119
213397-002	S Memara
Project No.	518
10.20.21	(Auner Apr
Dale	SANOSCA

TREE PROTECTION **PLAN**

TP100



PLANT SO	CHEDU	JLE					
TREES	CODE	QTY	BOTANICAL / COMMON NAME	CONT	CAL	<u>HT</u>	
0	WL	9	LIGUSTRUM JAPONICUM / WAX LEAF LIGUSTRUM TREE-FORM, MIN, 3 TRUNKS, SPECIMEN QUALITY	30 GAL	0,75"CAL	8"	
PALM TREES	CODE	OTY	BOTANICAL / COMMON NAME	CONT	CAL	HT	
0	SP	29	SABAL PALMETTO / SABAL PALM CLEAR-TRUNK HEIGHT NOTED	FG		14-16° H	
SHRUBS	CODE	OTY	BOTANICAL / COMMON NAME	CONT	HT	w	SPACING
\odot	DI	41	DIETES IRIDIOIDES / AFRICAN IRIS	3 GAL			42" a.c.
\circ	IN	17	ILEX VOMITORIA 'NANA' / DWARF YAUPON HOLLY	3 GAL			36" o c
0	SR	25	SERENOA REPENS / SAW PALMETTO	3 GAL			48" o.c.
SHRUB AREAS	CODE	QTY	BOTANICAL / COMMON NAME	CONT	HT	w	SPACING
m tr trans	MS	7	MISCANTHUS SINENSIS 'ADAGIO' / ADAGIO MAIDEN GRASS	3 GAL			42" o.c.
SOD/SEED	CODE	QTY	BOTANICAL / COMMON NAME	CONT	<u>HT</u>		
	SOD	2,475 SF	CYNODON DACTYLON "TIFWAY 419" / TIFWAY 419 BERMUDA GRASS	SOD			

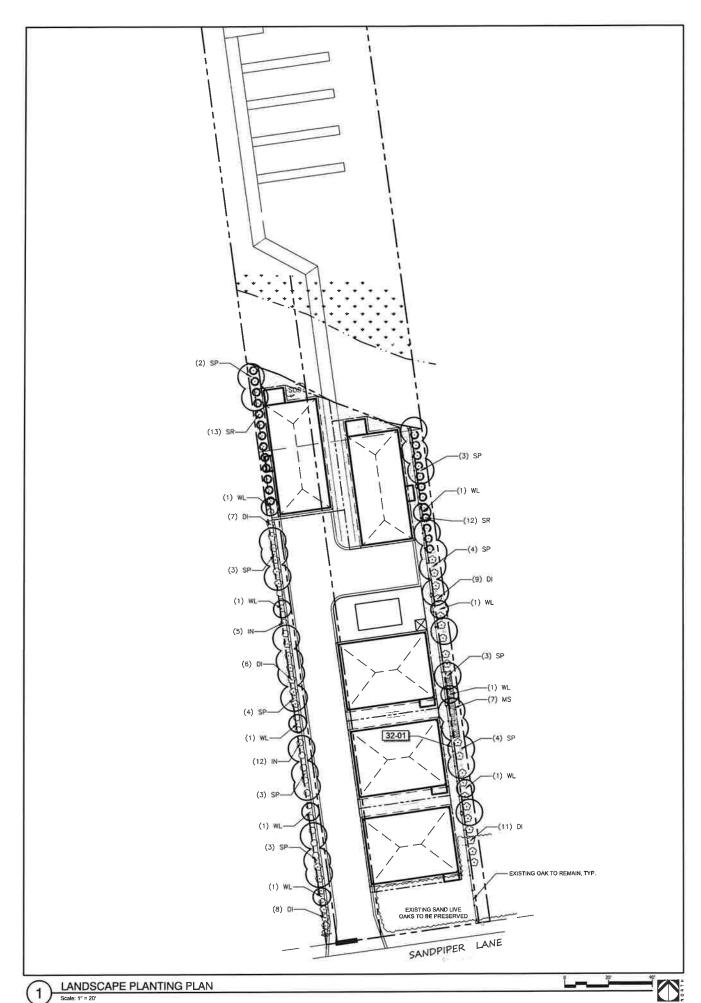

IRRIGATION NOTE:
ALL LANDSCAPE AREAS SHALL HAVE
AN AUTOMATIC, UNDERCROUND
IRRIGATION SYSTEM THAT SHALL
PROVIDE 100% HEAD—TO—HEAD
COVERAGE.

LANDSCAPE AREA REQUIREMENTS (12-1.B) 18,353 s.f. Required Landscape Area (20%): 5,100 s.f. Provided Landscape Area: STREET FRONTAGE REQUIREM ENTS (12-1.D) Sandpiper Lane Existing vegetation preserved in lieu of street frontage requirement PERIMETER LANDSCAPE REQUIREMENTS (12-1.F) 1 tree per 25 LF @ 180 0 LF = 7 20 trees Total Perimeter Shrubs Required: 29 shrubs Total Perimeter Shrubs Provided: 29 shrubs 1 tree per 25 LF @ 267 0 LF = 10 68 trees 4 shrubs per 25 LF @ 267 0 LF = 42 72 shrubs Total Perimeter Shrubs Required: 43 shrubs Total Perimeter Shrubs Provided: 43 shrubs





Sand Piper
Gulf Shores, Alabama

No.	Date	Revisions / Submissions
	10.25.21	PERMIT SUBMITTAL
	01.07.22	PERMIT RESUBMITTAL
	01.18.22	REVISED PER CITY COMMENTS
	01-20-22	REVISED PER CITY COMMENTS
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_	-	
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YJ
Drawn
DM
Project Manager
LCW
Principal
213397~00:
Project No.
10.20.21
Date



heat Title

LANDSCAPE PLANTING PLAN

Sheet N

LP100

FENCE ELEVATION

32 9399-05

CENERAL CONDITIONS

CONTRACTOR SHALL BE RESPONSIBLE FOR THE SITE INSPECTION PRIOR TO LANDSCAPE CONSTRUCTION AND INSTALLATION IN ORDER TO ACQUAINT HIMSELF WITH EXISTING CONDITIONS. CONTRACTOR SHALL BE RESPONSIBLE FOR LOCATING ALL EXISTING UNDERGROUND UTILITIES BEFORE BEGINNING CONSTRUCTION.

CONTRACTOR IS RESPONSIBLE FOR PROTECTION OF LANDSCAPE MATERIAL AT ALL THESE LANDSCAPE CONTRACTOR TO COORDINATE SAPE STAGING AREA WITH GENERAL CONTRACTOR AND/OR OWNER.

CONTRACTOR SHALL GUARANTEE ALL PLANT MATERIAL, INCLUDING GRASS, FOR 365 CONSECUTIVE CALENDAR DAYS FROM SUBSTANTIAL COMPLETION OF THE WORK, AS DETERMINED BY THE PROJECT LANDSCAPE ARCHITECT.

ALL AREAS IMPACTED NEGATIVELY BY CONSTRUCTION PROCESSES SHALL BE RETURNED TO ORGINAL CONDITION OR BETTER PRIOR TO SUBSTANTIAL COMPLETION.

SOIL STAALL BE MANENDED BY THE ADDITION OF COMPOST AND FERTILIZER. COMPOST TYPE SHALL BE MUSSIRROOM COMPOST OR DECOMPOSED PINE BARK, AND SHALL BE APPROVED BY LANDSCAPE ARCHITECT PRIOR TO PURCHASE. COMPOST SHALL BE UNIFORMLY APPLIED OVER PLANTING BEDS AT AN AVERAGE DEPTH OF 3/4 NICHEMENT.

SHALL BE UNIFORMLY APPLIED OVER PLANTING BEDS AT AN AVERAGE DEPTH OF 2 INCHES AND OVER SOO AREAS AT AN AVERAGE DEPTH OF 2/4 INCH. INCORPORATE COMPOST UNIFORMLY IN PLANTING BEDS TO A DEPTH OF 6 INCHES AND IN SOO AREAS TO A DEPTH OF 3 INCHES USING A ROTARY TILLER OR OTHER APPROPRIATE EQUIPMENT, PRE-PLANT FERTILIZER AND PH ADJUSTING AGENTS (E.G., LIME AND SULFUR) MAY BE APPLIED IN CONJUNCTION WITH COMPOST INCORPORATION, AS NECESSARY. RAKE SOIL SURFACE SMOOTH PRIOR TO PLANTING. REMOVE STONES LARGER THAN 1 INCH IN ANY DIMENSION AND STICKS, ROOTS, RUBBISH, AND OTHER EXTRAVEOUS MATTER AND LEGALLY DISPOSE OF THEM OFF OWNER'S PROPERTY.

PROPERTY.

WATER THOROUGHLY AFTER PLANTING.
CONTRACTOR SHALL BE RESPONSIBLE FOR PROVIDING 3% POSITIVE DRAINAGE IN
ALL PLANTING BEDS. ANY OTHER PROPOSED DRAINAGE METHODS SHALL BE
CORDINATED WITH PLANTING FFORTS TO MINIMIZE CONFLICTS AND MAINTAIN
PROPER FUNCTION OF DRAINAGE SYSTEMS.

Scole: 1/8" = 1"-0"

PLANT MATERIAL AND PLANTING

PLANT QUANTITIES ARE OFFERED AS A CONVENIENCE TO THE CONTRACTOR, AND ARE NOT ABSOLUTE. CONTRACTOR SHALL VERIFY PLANT COUNT FROM PLAN AND REPORT DIFFERENCES.

ALL PLANT MATERIALS ARE SUBJECT TO APPROVAL OR REFUSAL BY THE OWNER OR LANDSCAPE ARCHITECT AT THE JOB SITE.

PLANTS SHALL BE WELL FORMED, VIGOROUS, GROWING SPECIMENS WITH GROWTH TYPICAL OF VARIETIES SPECIFIED AND SHALL BE FREE FROM INJURY, INSECTS AND DISSESS. PLANTS SHALL EQUAL OR SURPASS QUALITY AS DEFINED IN THE CURRENT ISSUE OF "AMERICAN TANDARDS FOR NURSERS STOCK" AS PUBLISHED BY THE AMERICAN NURSER*MEN, INC. UNLESS MOTED SPECIFICALLY, ALL PLANT MATERIAL SHALL BE BALLED AND BURLAPPED OR CONTAINER GROWN.

BURLAPPED OR CONTAINER GROWN.

FRONT ROW OF SHERUS SHALL BE PLANTED FROM CENTER OF PLANT A MINIMUM OF 36" BACK OF CURB © PARKING SPACES.

NO PRUNING SHOULD BE PERFORMED DURING FIRST GROWING SEASON EXCEPT FOR REMOVING DAMAGED OF DEAD GROWTH. WOUND PAINT IS NOT RECOMMENDED FOR ARY CUTS.

ALL PLANTING AREAS, TREE PITS, AND OTHER AREAS INDICATED ON PLANS SHALL BE MULCHED WITH A SETTLED LAYER OF THE INDICATED MULCHE:

3" DEPTH PINE BARK

3" DEPTH PINE BARK

4" DEPTH SHREDDED HARDWOOD MULCH 3" DEPTH LONGLEAF PINESTRAW, SETTLED

TRENCH EDGE TO BE LOCATED BETWEEN ALL PLANTING AREAS AND LAWN,

TRENCH EDGE TO BE LOCATED BETWEEN ALL PLANTING AREAS AND LAWN, UNLESS NOTED OTHERWISE, SOUTHER OF THE STAKING SHALL BE PROVIDED TO KEEP TREES PLUMB AND PROTECTED NOTE: FROM EXCESSIVE WINDS. ALL TREE-STAKING APPARATUS SHALL BE REMOVED AT THE END OF THE ONE-YEAR WARRANTY PERIOD.

ONE YEAR OF LANDSCAPE MAINTENANCE FROM SUBSTANTIAL COMPLETION SHALL BE INCLUDED AS AN OPTIONAL BID ITEM TO THE OWNER.

NOTE: BUD SHALL BE PERPENDICULAR TO GROUND PLANE. TRUNK SHALL BE STRAIGHT AND WITHOUT CURVES. NO DAMAGED, SCARRED OR BLACKENED TRUNKS. HURRICANE CUT OR FULL BASE OF LEAF BASE OF HEART/NUT OF PALM BURLAP TO PROTECT TREE—— MINIMUM 5 LAYERS 2 NON-SLIP METAL - (6) 2 X 4 WOODEN STRIPS OVER BURLAP MULCH PER SPECS (3) 2 X 4 BRACES NAILED TO 2 X 4 WOODEN STRIPS - 2"x4"x3' STAKE PLANT PALM 0-2" ABOVE - PLANTING SOIL UNDISTURBED SUBGRADE PALM TREE PLANTING (8) 3/8" = 1'-0"

7 GENERAL PLANTING NOTES

SOLID PANEL WOOD FENCE 32 3129,23-01

HOUSE SIDE. 1 X FACE BOARDS

2X4 MERCHANT REDWOOD
 TOP RAIL.

2X4 MERCHANT REDWOOD BOTTOM RAIL

8" DIAMETER CONCRETE

SET POST 3" MINIMUM INTO GRAVEL BASE DO NOT COVER BOTTOM OF POST WITH CONCRETE FOOTING


SET ROOTBALL CROWN 1 " HIGHER THAN SURROUNDING FINISHED GRADE.


PLANTING P SLOPE FINISHED GRADE AT BACKFILL AWAY FROM ROOTBALL MULCH TO DEPTH AT WATER WELL. FINISHED GRADE. ROOTBALL PLANTING TABLETS, AGRIFORM OR EQUAL, PER MANUF. RECOMMENDATIONS BACKFILL WITH A MIXTURE
OF PLANTING PIT SPOIL
AND PREPARED PLANTING
SOIL, PER SPECS, FROM
ADJACENT PLANTING AREA 2 X ROOTBALL

-CROWN MULCH NEAR EDGE IN A BERM-LIKE MANNER AS SHOWN OR TOP OF CURB/
PAVING GRADE -MULCH LAYER SUBGRADE

NOTE: TRENCH EDGE TO BE LOCATED BETWEEN ALL PLANTING BED AREAS AND ADJACENT TURF AREAS, UNLESS NOTED OTHERWISE.

TRENCH EDGE

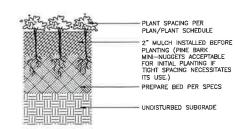

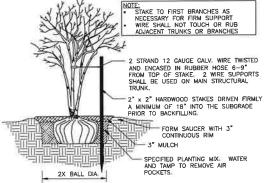

GROUNDCOVER PLANTING

MULTI-TRUNK TREE STAKING 32 9313-01 5 MULTI-TF

DESIGN Parsacold, Florida

THESE PLANS HAVE NOT BEEN

Piper ঠ Sand Shores

No. Date Revisions / Submissions 10.25.21 PERMIT SUBMITTAL 01,07.22 PERMIT RESUBMITTAL 01.18.22 REVISED PER CITY COMMENTS 01.20.22 REVISED PER CITY COMMENTS

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THE OF ALAD

213397-002 Project No.

A CHARLER 518 10.20.21

LANDSCAPE PLANTING DETAILS

LP500

TYPICAL PLANT SPACING

BEDLINE-

SHRUB PLANTING 2

FORM 3"

CONTINUOUS

SAUCER AROUND

32 9333.13-01

INDISTURBED SUBGRADE

(3) 3" - 1'-0"

4) GROUN 3" = 1'-0"

32 9343-01


6

SHRUBS AND GROUNDCOVERS ADJACENT TO STRAIGHT EDGES SHALL
BE TRIANGULAR — SPACED IN ROWS PARALLED TO THE STRAIGHT

B SHRUBS AND GROUNDCOVERS ADJACENT TO CURVED EDGES SHALL BE PLANTED IN ROWS PARALLEL TO THE CURVED EDGES. CURVED EDGES TO BE VERY SMOOTH RADII.


32 9413 23-02

LUMI	NAIRE	SCF	HEDULE						
CALLOUT	SYMB0L	LAMP	BALLAST	MOUNTING	MODEL	VOLTS	NOTE 3	QUANTITY	DEFAULT ELEVATION
POLE	⊕	(1)	ELECTRONIC	POLE	Visionaire Lighting LLC	120V 1P 2W	COMPUTE, Visionaire Lighting Photometric Laboratory, 09/24/2020, 120 VAC, 1105W, B1-U0-G1, 1694, 3343	4	15'-0"

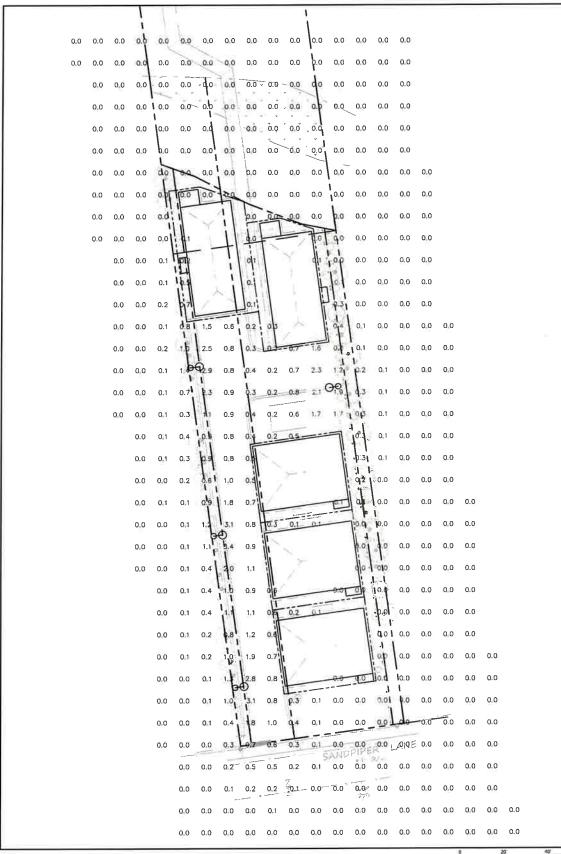

STRUCTURAL ENGINEERING NOTE

STRUCTURAL ENGINEERING DESIGN IS NEITHER EXPRESSED NOR IMPLIED IN THIS DRAWING. STRUCTURAL ENGINEERING DESIGN RESPONSIBILITY IS DELECATED TO THE CONTRACTOR, AND SHALL BE DONE BY A PROFESSIONAL ENGINEER OR OTHER QUALIFIED PROFESSIONAL AS REQUIRED FOR CODE COMPLIANCE, PERMITTING, ETC.

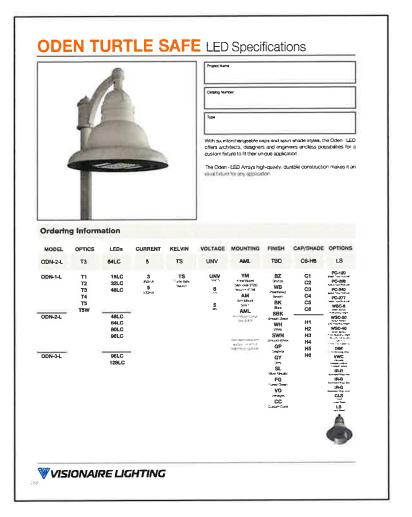



FOR CONSTRUCTION
THESE PLANS HAVE NOT BEEN
APPROVED AND ARE SUBJECT

Sand Piper
Gulf Shores, Alabama

		998416394103
No.	Date	Revisions / Submissions
_	10.25.21	PERMIT SUBMITTAL
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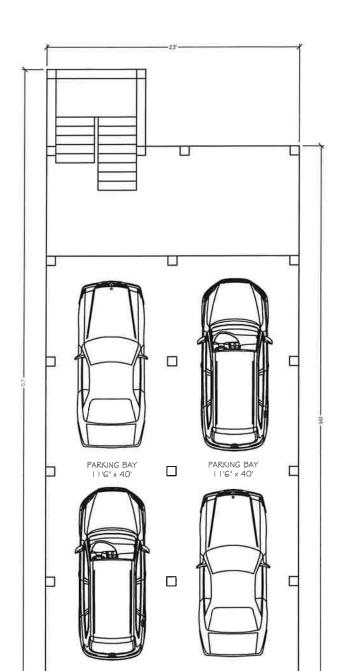
Sheet Title

SITE LIGHTING PLAN


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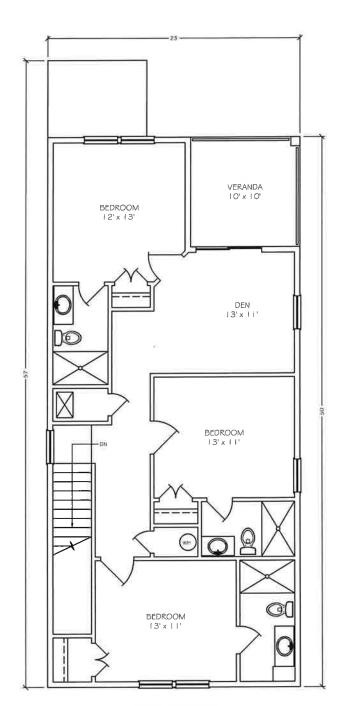
SITE LIGHTING PLAN







920 S.F. - HEATED AND COOLED 1,150 S.F. - TOTAL CONSTRUCTION

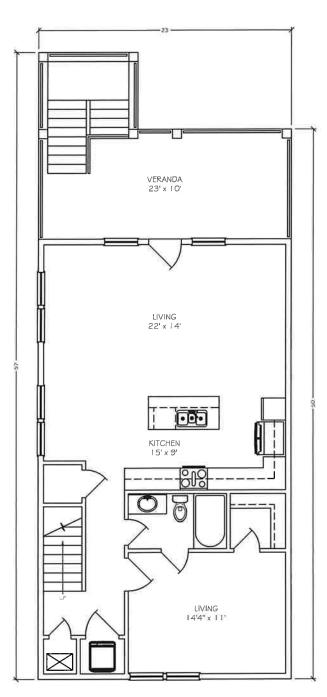

2ND FLOOR PLAN 1,050 S.F. - HEATED AND COOLED 1,150 S.F. - TOTAL CONSTRUCTION



SANDPIPER COTTAGES
1476 SANDPIPER LN
GULF SHORES, ALABAMA

JOB NUMBER: 211049

DATE:

10.18.2021

DRAWN: CG CHECKED: CG REVISION:

SCALE:

1/4" = 1'-0"

SHEET NO:

01 OF

06





SANDPIPER COTTAGES
1476 SANDPIPER LN
GULF SHORES, ALABAMA

JOB NUMBER: 211049

10.18.2021

DRAWN: CG CHECKED: CG REVISION:

1/4" = 1'-0"

SHEET NO:

02

06